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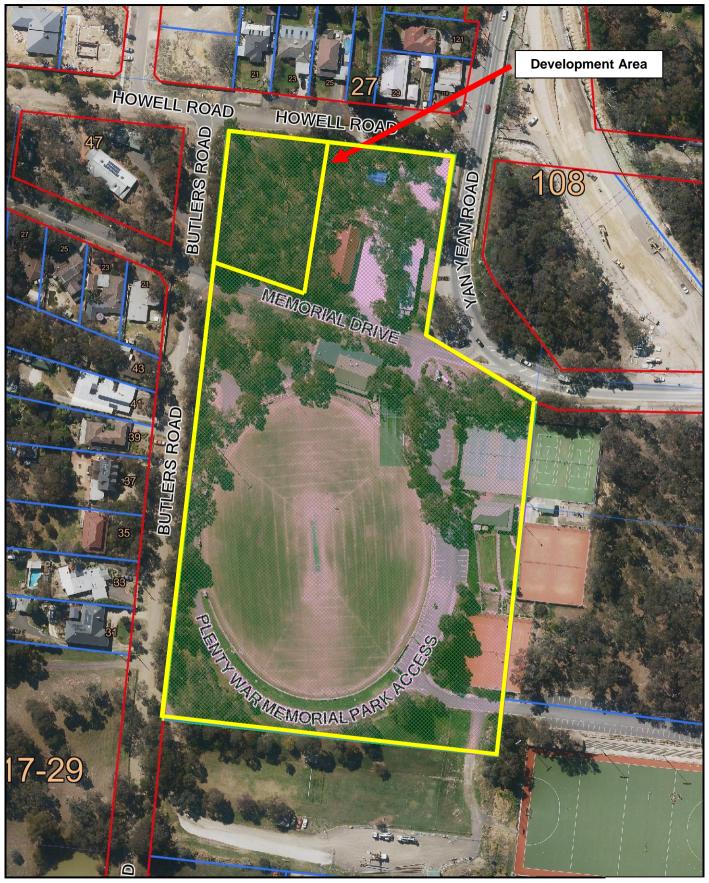
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961.3 m					
Planning and Building Services					
Eloise Gabriele					
Friday, 15 February 2019					





Nillumbik Shire Council

109-115a Yan Yean Road, Plenty





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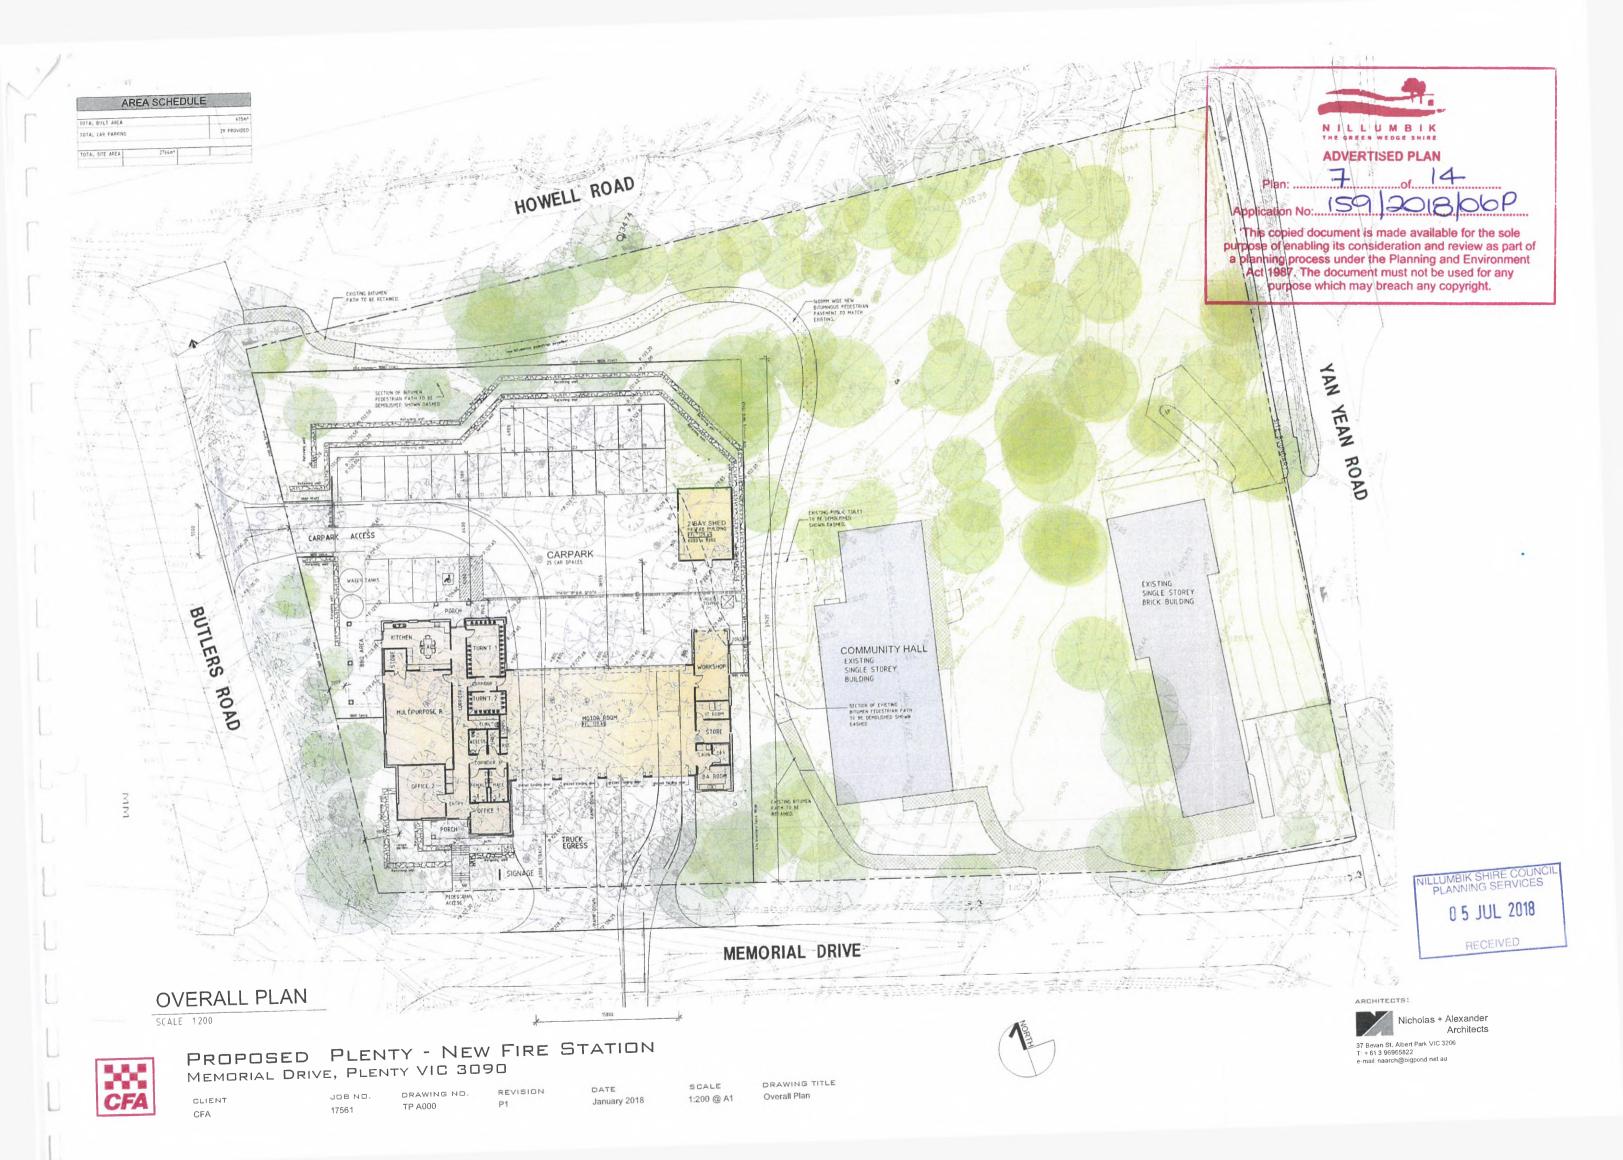
Map Width: 336.9 m

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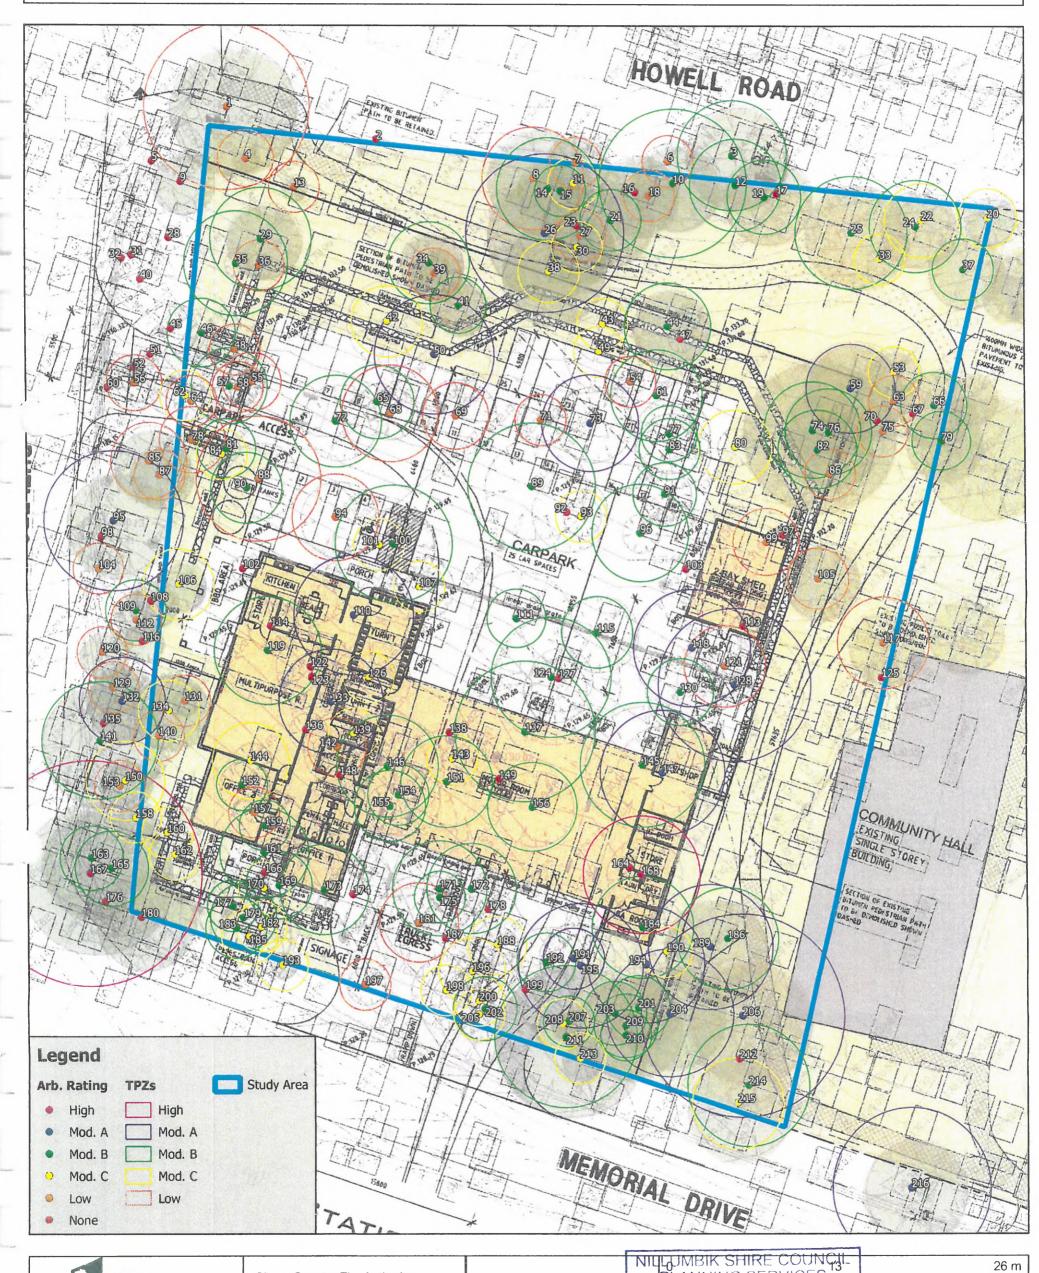






Appendix 2 - Tree Location Plan Plenty Fire Station

Tree location points on this plan are based on the survey plan provided by the client.



Treelogic

Client: Country Fire Authority Map Source: Nearmap Author: Tree Logic Date: 08/06/2018


Proposed Site


PLANNING SERVICES

- 5 JUL 2018

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NILLUMBIK THE GREEN WEDGE SHIRE **ADVERTISED PLAN**

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2018

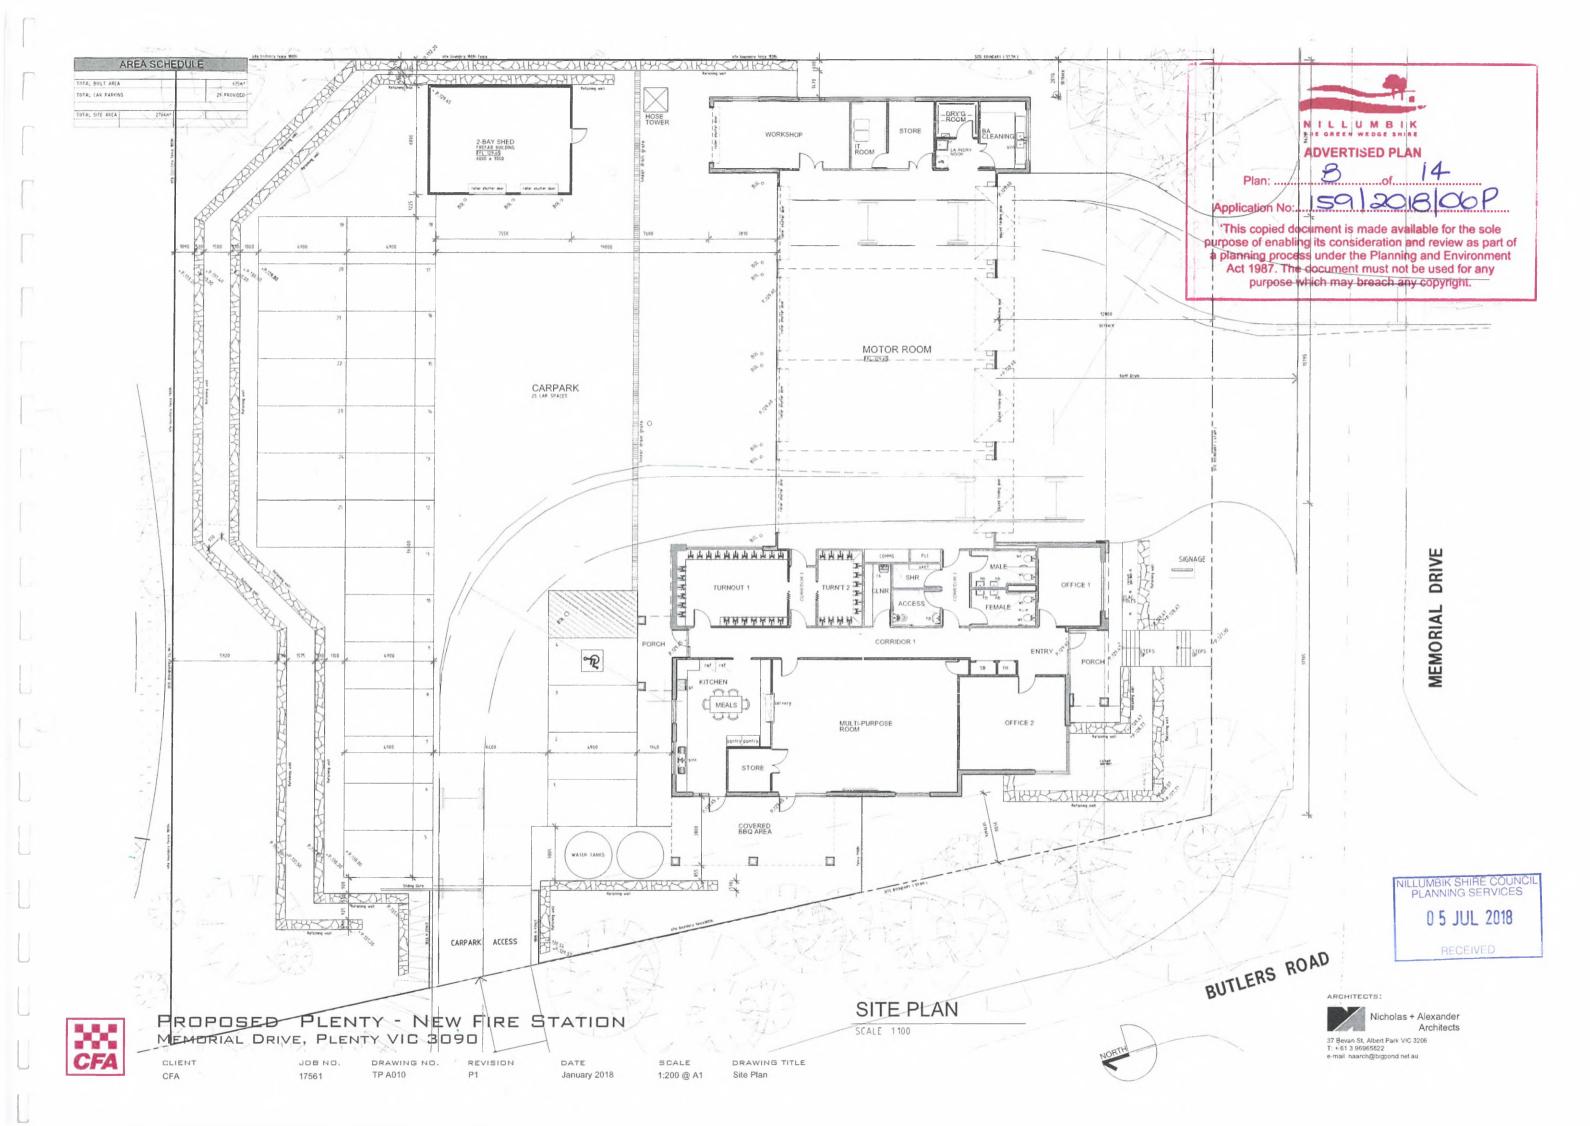SOUTH ELEVATION

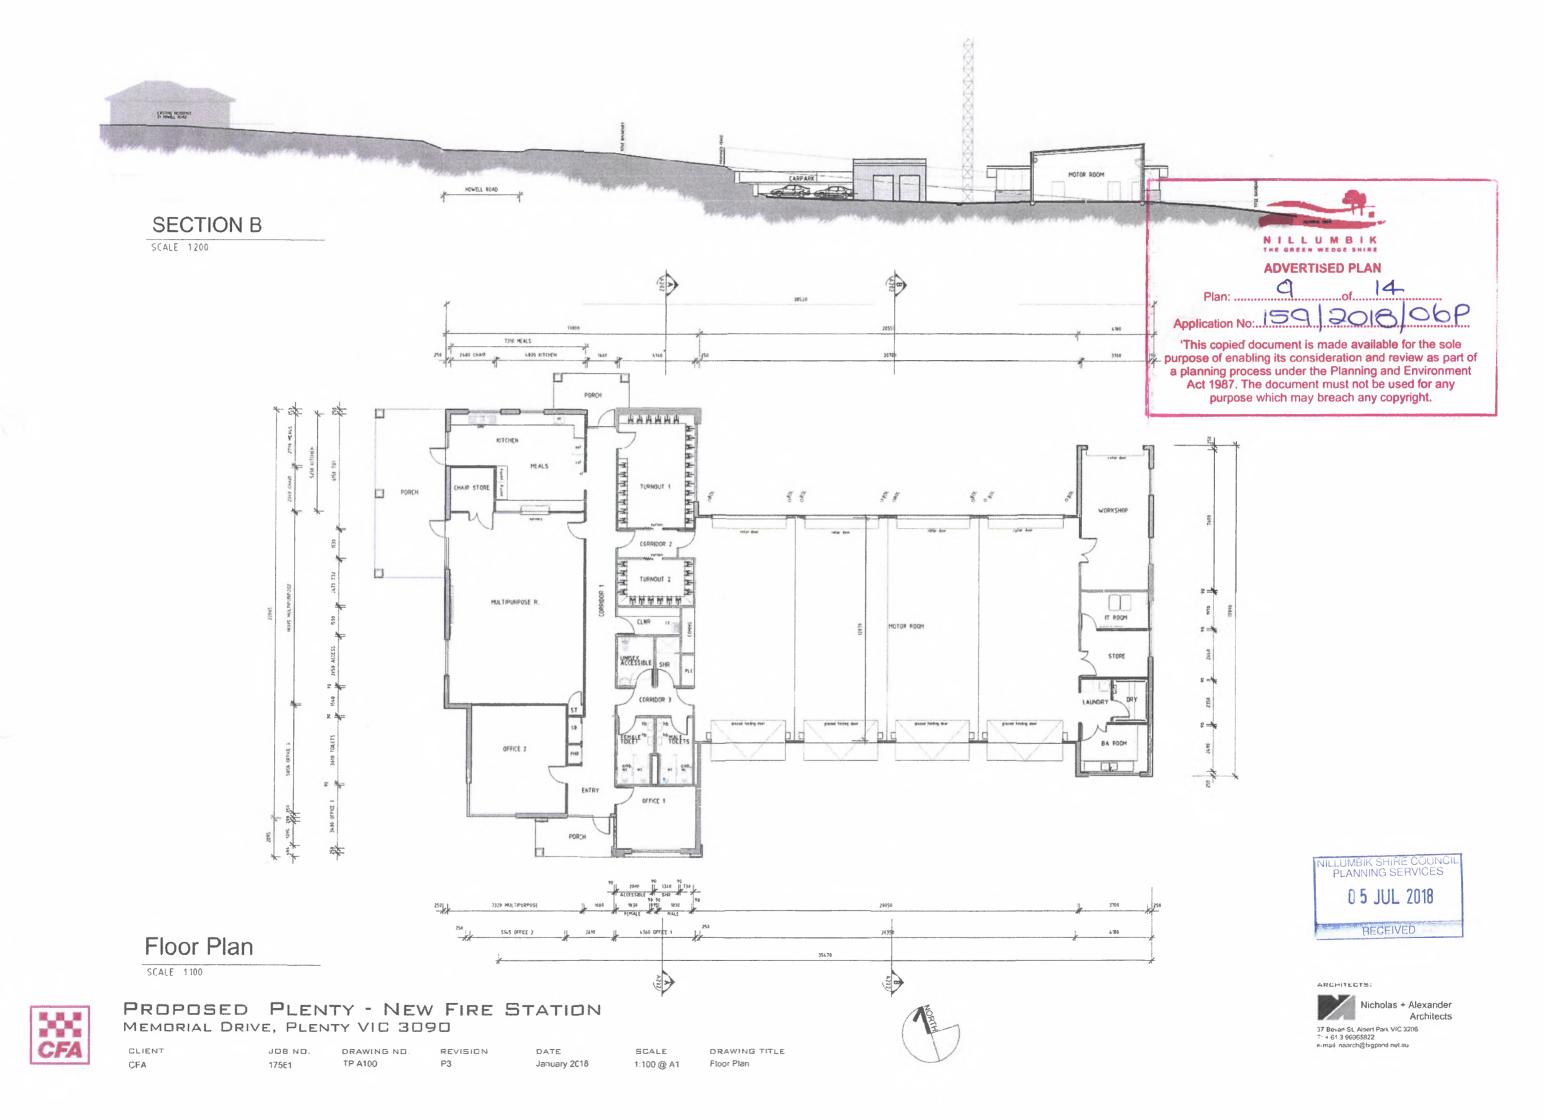

GAE ON BASKET RETAINING WALLS 30 NATURAL STONE NATURAL STONE CLADOING (C) FIRRE CEMENT SHEET CLADONG €03 FBIRE CEMENT SHEET CLADURYS 35) FACE BRICKWORK WALL PGH BRIGKS "CHOCOLATTO" OR SIMILAR APPROVED CORRUGATED METAL CLAPOING COLORBONO FIN SHE SHALE GREY OR SHALLAF APPROVED ORNUGATED AND TALL CLAUDING COLORBOND FINEH - BASALT DEVOCEPA PAUMIS SO GP CORRUGATED ROOF SHEETING RAIR WATER GOODS COLORBOND FINISH BASALT OR SIGN AF AFPROVED PAINT FAISH TO MATCH COLORBOND BASALT OR SMILAH APPROVED ROLLER SHUTTER DOORS

WEST ELEVATION

SEALE 1:100

*** **CFA**

PROPOSED PLENTY - NEW FIRE STATION MEMORIAL DRIVE, PLENTY VIC 3090

CLIENT CFA

17561

JOB NO.

DRAWING ND. TP A200

REVISION P3

November 2017

DATE

SCALE 1:100 @ A1

DRAWING TITLE Elevations

NILLUMBIK SHIRE COUNCI PLANNING SERVICES


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Nicholas + Alexander Architects

37 Bevan St Albert Park ViC 3206 T + 61 3 96965822 e-mail naarch@bigpond net au





PROPOSED PLENTY - NEW FIRE STATION MEMORIAL DRIVE, PLENTY VIC 3090

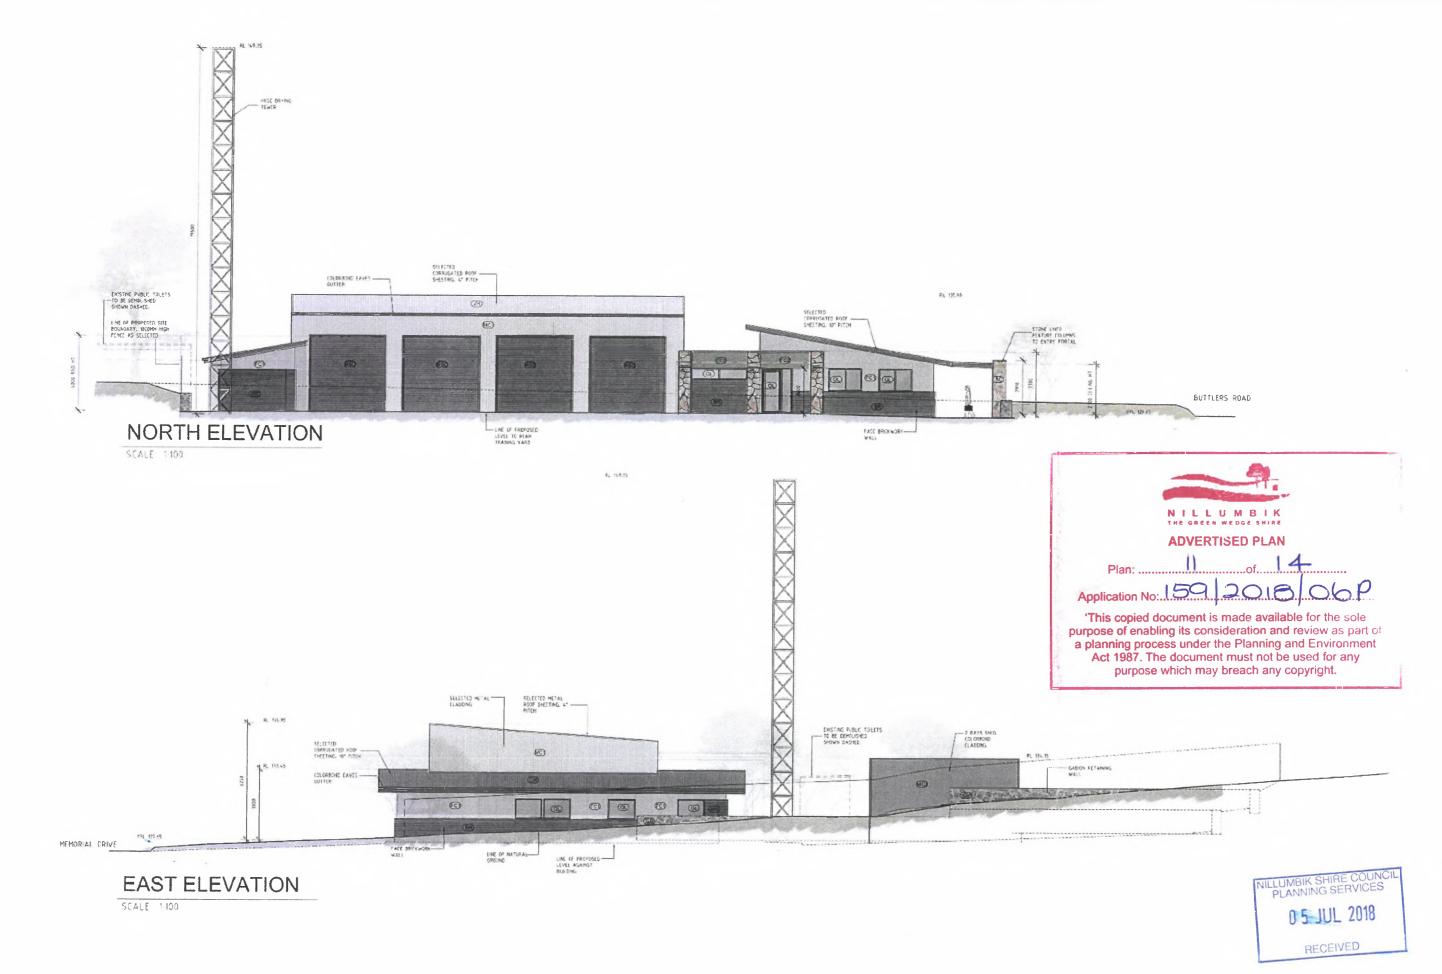CLIENT

JDB ND. 17561

3 NO. D

DRAWING NO. TP A201 REVISION P3 November 2017


5CALE 1:100 @ A1 DRAWING TITLE
Elevations

ARCHITECTS:



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SCALE 1100

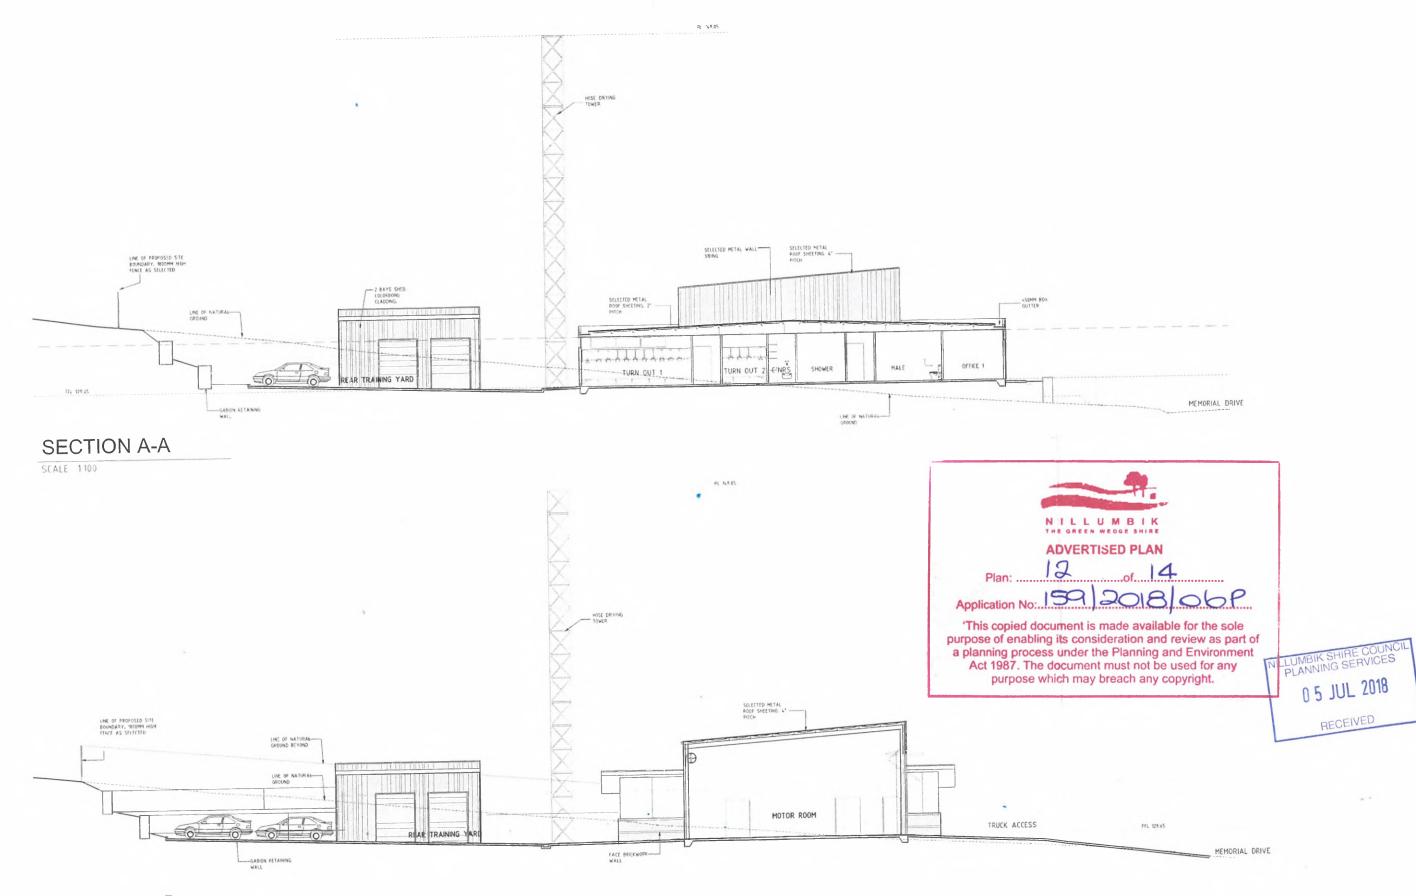

PROPOSED PLENTY - NEW FIRE STATION MEMORIAL DRIVE, PLENTY VIC 3090

CLIENT CFA

JOB NO. 17561

DRAWING NO. TP A202

REVISION P2

November 2017


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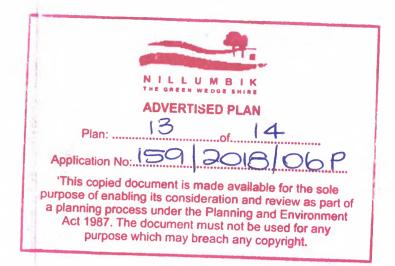
Sections

ARCHITECTS:




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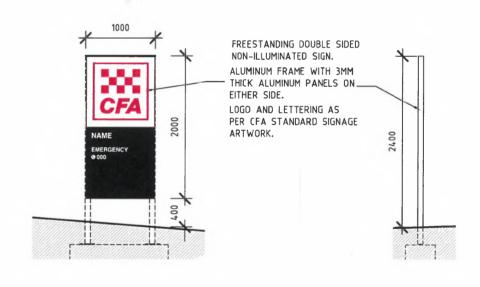


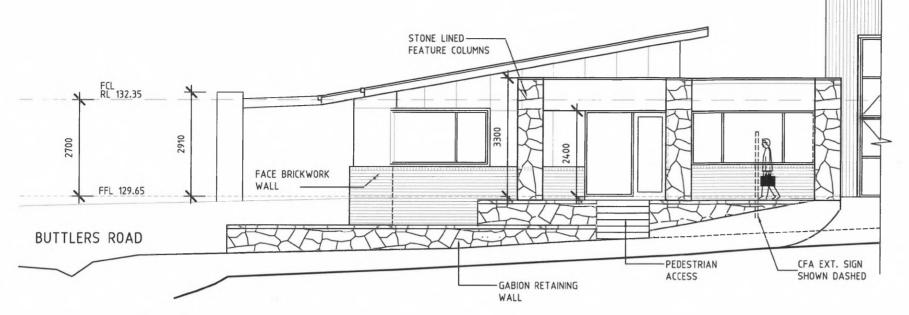

PART - SOUTH ELEVATION

SCALE 1:100



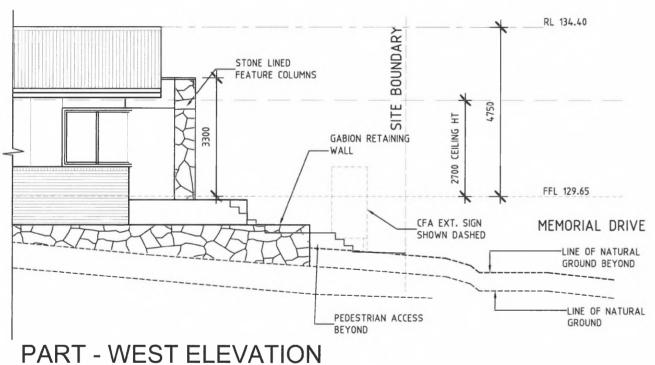

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SCALE 1:50 FRONT VIEW

CFA SIGN DETAIL

SCALE 1:50 SIDE VIEW



SCALE 1:100

PROPOSED PLENTY - NEW FIRE STATION MEMORIAL DRIVE, PLENTY VIC 3090

P1

CLIENT

CFA

JOB NO.

17561

DRAWING NO.

TP A300

REVISION

DATE

SCALE

DRAWING TITLE

1:100 @ A3

CFA SIGN DETAIL

SIGNAGE DETAIL

ARCHITECTS:



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Tile trees immediately after planting wi

75mm depth of organic mulch or as specified

Backfill hole with existing site soil broken up to a friable texture. Pac around root ball to stabilise and at rest of backfill to settle naturally, o tamp lightly

LEGEND















NOTE:

Dig hele twice as deep as root ball and allow at least
200mm eround sides for backfilling with topsoil.

Apply fertillier in base of hole, cover with topsoil
type is rate as per ages.) Avide root contact.

Pauce plant to centre of hole, backfill with specified
topsoil, firming progressively—amount related.

NOTE:
Place plants in position according to densities required and prepare planting horse, with as minimal soil disturbance as possible, to a minimum size of 150mm deep x 200mm in demeter. Paints shall be thoroughly sociated us immeration in water prior to planting, if the site soil is very dry then planting holes are also to the file of with water and allowed to their in the planting.

completely.

Place plant in hole so that top of soil level in pot matches surrounding soil level. Book fill with existing alle lepsoil. removing any debts limiting to plant growth. Provide were metting or mulch area as specified taking care to keep miclear of plant siem. All plants are to be thoroughly water after planting.





PLANT SCHEDULE

SYM	BOTANICAL NAME	COMMON NAME	DIE NÆx*	HEIGHT X WIDTH AT MATURITY	MIN SUPPLY SIZE	QTY
TREES						
Am	Acacla melanoxylon	Bleckw ood	E/N	12-20 x 6-10m	30cm/1.5mH	4
At	Allocesuarine torulose	Forest Sheoak	E/N	8-5 x 5-10m	30cm/1.5mH	18
Br	Eucalyptus rubida	Candle Bark Gum	E/N	10-30 x 10-15m	30cm/1.5mH	2
					TOTAL	16
SHRUBS						
Bm	Brechyscome multiflda	Out-leaf Dalsy	EN	0.4 x 0.4m	140mm pot	
Cg	Correa glabra	Rock Corres	E/N	1.2 x 1.2m	140mm pot	TLD
CgiL	Correa glabre Tvory Lentern'	Compact Rock Correa	EN	0.5 x 0.5m	140mm pot	
					TOTAL	0
GROUNDCO	WERS & GRASSES					
Ca	Chrysocephalum apiculatum	Common Everlasting	E/N	0.5 x 0.8m	140mm pot	
DI	Dienella longifolia ver longifolia	Pale Flax Lify	E/N	0.75 x 0.75m	50mm tube	
Enn	Elnadia nutaris sap, nutaris	Nodding Sattbush	₽N	0.3 x 1.2m	50mm tube	
HFE	Hardenbergle violecea 'Free 'n' Easy'	Free 'n' Easy Coral Pea	E/N	0.15-0.3 x 1.5m	50mm tube	TLD
и	Lomandra longifolia	Spiny-headed Mat-rush	EN	1 x 1-1.6m	50mm tube	
PI	Poe labillardieri	Tussock Grass	EN	0.8 x 0.8m	50mm tube	
Vh	Viola hederacea	Native Violet	EN	0.15 x Spreading	140mm pot	
					TOTAL	0
		*D/E = Deciduous/Evergreen	N/Ex = Nativ	e/Exotic		

SPECIFICATION NOTES

Soil Preparation
Crushed rock, concrete spillage and any other material restrictive to plant growth
(e.g., large rocks) shall be removed from the site of any planting bods and
semi-advanced treas. At trees to be removed shall be sturng ground and all
mobish/vegstaine sport is to be removed from falls. Existing ground and all
rareas is to be preserved so that it does not nucleic additional compaction for
the machinery and so that no rubble or building stupplies are stored in hete

No imported top soil is to be used within the root zones of frees to be protected. Any preparation of existing soil for planting within these areas is to be done by hand only. Holes (e.g. as the result of plant removal) and uneven soil levels may be patched using topsoil as specified below.

Any imported topool is to be free of weeds, rubble and other materials damaging to plant growth and is to be of a medium feature (sandy loam) with a pH of 6.0-70. Top soil is to be lidit over a prepared sub-base which has had any materials damaging to plant growth (e.g., rubble and large rocks) removed, spread to the appropriate depth and cultivated int.

a the existing site soil to a minimum depth of 150mm

Imported top soil is to be lightly and uniformly compacted in 150mm layers to a minimum depth of 100mm on lawn areas and 300mm on excavated planting beds.

Weed Removal All weeds shall be thoroughly removed. All vegetative material, including roots and ritizones of non-woody parennials and woody suckering weeds, is to be removed or appropriately controlled using chemical inseans. The stumps of non-audicating woody persentials are to be etump gound. All vegetative material shall be appropriately disposed of oil size in a manner which will not allow the new constitution of the stumps of the supportance of the stump of the supportance of t

Care must be taken to ensure that all trees to be retained are not damaged during weed removal. This also implies that any herbicides used are suitable for use around the vecetation to be retained.

Planting
Planting statible carried out using accepted horicultural practices with all plants
conforming to the species, size and quantities indicated on the Landscape Plan
and Plant Schedule. Plants shall be thoroughly sealed through immersion in
water price to planting end if the fainting soil as very dry then the planting hole is
also to be filled with water and allowed to drain completely.

All plants shall be appropriately hardened off in the nursery. Use plants with the following characteristics. Large healthy root systems with no evidence of root curl or pot bound restriction or damage, vigorous, well established, free from disease and pasts and of good form, consistent with the species or variety.

Mutch is to be supplied to all genden beds and is to be an organic type last to a minimum depth of 75mm, consisting of firm derk coloured disposed or shredded minimum depth of 75mm, consisting of firm derk coloured disposed or shredded programment of the coloured of the coloured of the coloured of the coloured programment of the coloured of the coloured of the coloured forms x 25mm a 5mm and the maximum length is not to exceed 5mm. Match shall be free of damaging matter such as soil, weeds and stacks and is to be stockpied and throughly weathered prior to delevery. Mutch is to be kept back 100mm from the stems of all plants to prevent colar rot.

Granitic Gravel Surface

usrantuc Gravet surrace
Granitic gravel is to be installed where shown comprising of a 50mm layer of
gravel (Tuscan Toppings or similar) over a base course of 75mm deep gently
compacted Fine Crushed Rock. Each layer, including the subgrade is to be

Timber Edges
Provide 75 x 25mm treated pine edges to all borders between gravel mulch
paths, Iswns end gerden bede using 75x25x300mm iong treated pine stakes et
1200mm maximum centres. An additional stake is to be provided at joins in the

Irrigation
An approved drip Irrigation system is to be supplied to all garden bads. It is the responsibility of the constactor to ensure that all irrigation meets manufacturers specifications. The system is to be connected to martis supply and include a cain-strut off device. All dripline is to be burned with approx. 50mm of topsoil cover and shall be enriched at Irrigation Irringation sensure the burner cannot be

An appropriate native grass seed (eg. Microlaena atipoides - Weeping Grass or similar mbx) is to be sown as lawn.

Topcoil is to be moistened to its full depth prior to the application of seed. Seed to be sewed 10-15 mm bolow the soil surface. Germination may take from 10-14 days in spring or summer or considerably longer in cooler conditions. Sowing rate: "tightform" and spread in a manner that achieves even distribution. Lawn is to be impligated immoistably following sowing, either by head or through an Irrigation system, and is to consinue to be Irrigated until greas is fully established.

Any areas of lawn which have falled to germinate (achieve an evenly green 95% covering of a consistent height) are to be re-eeeded within one month of original sowing date.

Plant Establishment Period Three shall be a 13 weeks Plant Establishment Period following the approval of Practical Completion by the responsible authority. During this period the lendscape continentor shall make good all defects in his/her scope of works. Maintenance and Establishment means the care and maintenance of the control care by accepted hortculural practices, as well as recliffing any defects that become apparent in the work under normal use. This shall include, but shall not be fintled to watering, fertilisating, weeding, printing, pest and disease control, cultivation, re-stabling and replacement of any plants that fall with plants of the same species and size.

- Arboriculture.
- is to en or a manual meigra of 1,5m and a to 50 secure, so as so dideter easy entry. At least one westherproof sign per side is to be statedned to each fenced PTZ and is to clearly state TREE PROTECTION ZONE, ENTRY RESTRICTIONS APPLY, DO NOT REMOVE FENCE, CONTACT THE CONTRACTOR IF ENTRY IS REQUIRED. NO EXCAVATING OR TRENCHING, NO STORAGE O MATERIALS OR WASTE and is to have the Contractor's (or appointed site foremen) and Project Arbonist's confact details

- development process:

 No heavy machinery is to enter the fenced areas of the TPZ without the express permission of the Project Arborist (emergency service vehicles
- No trenched services are to pass through the TPZ. If services are required they are to be bored beneath the root zone to a depth approved by the Project Arborist, or non-destructively excavated, such as hydro excession, to retain significant roots in sits;

 No drainage or subsurface irrigation lines are to be installed;

 No faul, oil dumps or chemicals shall be allowed in or stored on the Tree Protection Zone. The servicing and refueling of equipment and vehicles must be carried out away from the root zone;

 No storage of materials, equipment or temporary buildings will take place over the root zone.

 No flutures of any sort shall be attached to the trees for any reason;

 The Project Arborist is to be consulted prior to heavy, machinery, accessing any of the fenced TPZ;

 All machinery is to be key tolder of the tree canopy to prevent impact

- All machinery is to be kept clear of the tree canopy to prevent impact
- If demane of any sort is to occur to any tree on site, the Project Arborist
- must be contacted to take immediate remedial action Any changes to the building/landscaping design which after surface or below ground works within the fenced TPZ are to be subject to the approval of the Project Arborist prior to proceeding

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CFA

New Fire Station

Plenty, Victoria, 3090

Landscape Plan for Town Planning

> DATE MARCH 2018 CHECKED OH 80L

TREE PROTECTION NOTES

Tree Protection measures are to be in eccordance with Australian Standard AS 4970 -2009 Protection of Trees on Development Sites

- All treat to be retained are to be identified and fenced off prior to demotified and construction works commencing, or any heavy machinery entering the site. Tree projection fencing is to be established to create an exclusion zone around the tree at the established to be unus specified as the Time Protection Zone (TPZ) or as indicated on the Landscape Plan. Once encoded, these areas are to be meistrained as to go Zones to limit terificially through the TPZs and avoid inadventent mechanical damage by construction vehicles and equipment during construction. Perside is to remain in place until soft landscaping works commence as part of the final stage of site works.
- 2 If access or temporary relocation of protective fencing is required e.g. to allow for the demolition of existing structures, it must be with the approval and supervision of a Project Abrorist. The appointed Project Abrorist is to be an appropriately experienced and skilled professional with a minimum qualification of Certificate V (or equivalent) in
- Tree Protection fancing is to be constructed of temporary security fencing (or similar) security fitted to block bases. No holes are to be dug for fence construction unless outside the specified TPZ. Fencing is to be of a minimum height of 1.8m and is to be secure, so as to
- The ground within all TPZs within the site (both fenced and unfenced) and outside of the building footprints is to be maintained with a 50-100mm layer of consens wooderlaps. Woodchips are to be well composed and are to be kept a meritimum of 300mm back from the tree's trunk. The soil surfaces is to be thoroughly well immediately prior to the installation of the multih layer. Unless during water estimations, irrigation is to be provided for each of the trees from December to March Inclusive. A weed control program is to be implemented for mulched areas.
- Any root and branch pruning requirements are to be carried out by the appointed Project Arborist and be in accordance with Australian standard AS 4373-2007 Pruning of Amenity Trees. Where a root diameter of 20mm or greater is encountered during site works, those shall be clearly pruned by hand, and never torn from the ground by
- Throughout construction works the Project Arborist is to undertake regular inspections of trees and carry out remedial works as required to ensure less estain good health and where necessary install additional trunk, branch or ground protection.

maintained. Carden beds must be constructed using ensiting site soil; No 8t to a depth graster than 100mm is to be installed: Any vegetation located within Tree Protection Conce is to be remove by hand so that no heavy machinery enters into TPZ;

D1 TYPICAL TREE PLANTING DETAIL

200 min

SUB-SOIL

TYPICAL PLANTING DETAILS

NOTE: Width of planting hole is: 3 times root ball diameter in highly compacted soil.* 2 times root ball diameter minimum in all others.* "Where available planting space is available.

Regularly check soft moisture of rootball with soil probe

Ensure trees are placed so as to match crown of not bell with sumrunding surface level. Carefully prune off any gliding roots ferm not bell. Form soil ring berm beyond the circumference of the root ball is provide a watering saucer around the immediate cown of tree. Spread specified mulch to tree surround at a minimum of 1,5m diameter from centre of tree.

Keen Ingsoil/mulch away from Inunk base.



D2 TYPICAL SHRUB PLANTING DETAIL

Scale N.T.S.

- Mulch 75mm depth or as specified

Break up sides and base of hole.